## **CITY OF CEDAR RAPIDS - CEDAR RAPIDS IOWA**

# LPO REACTOR WALKWAYS






CEDAR RAPIDS
WATER POLLUTION CONTROL DIVISION
WATER TREATMENT PLANT

LOCATION MAP

DRAWING INDEX					
SHEET NUMBER	HEET NUMBER SHEET TITLE				
G1	COVER SHEET	0			
G2	GENERAL NOTES AND LEGEND SHEET	0			
G3	MATERIAL SPECIFICATIONS	0			
G4	SOLIDS DEWATERING INCINERATION AND GRIT BUILDING EXISTING PLAN	0			
S1	FRAMING PLAN	0			
S2	TYPICAL DETAILS	0			

#### ATTACHMENT E

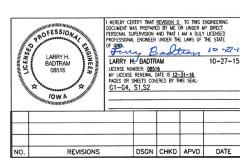




225 Iowa Avenue, Muscatine, Iowa 52761-3764 www.stanleyconsultants.com



CITY OF CEDAR RAPIDS LPO REACTOR WALKWAYS CEDAR RAPIDS, IOWA

COVER SHEET

DESIGNED_ DRAWN	JM CASE N VEGA	SCALE: NONE	SCALE: NONE	
CHECKED_	JM CASE	NO. 26302.01	REV.	
APPROVED				
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DATE	OCTOBER 27, 2015		١٠	

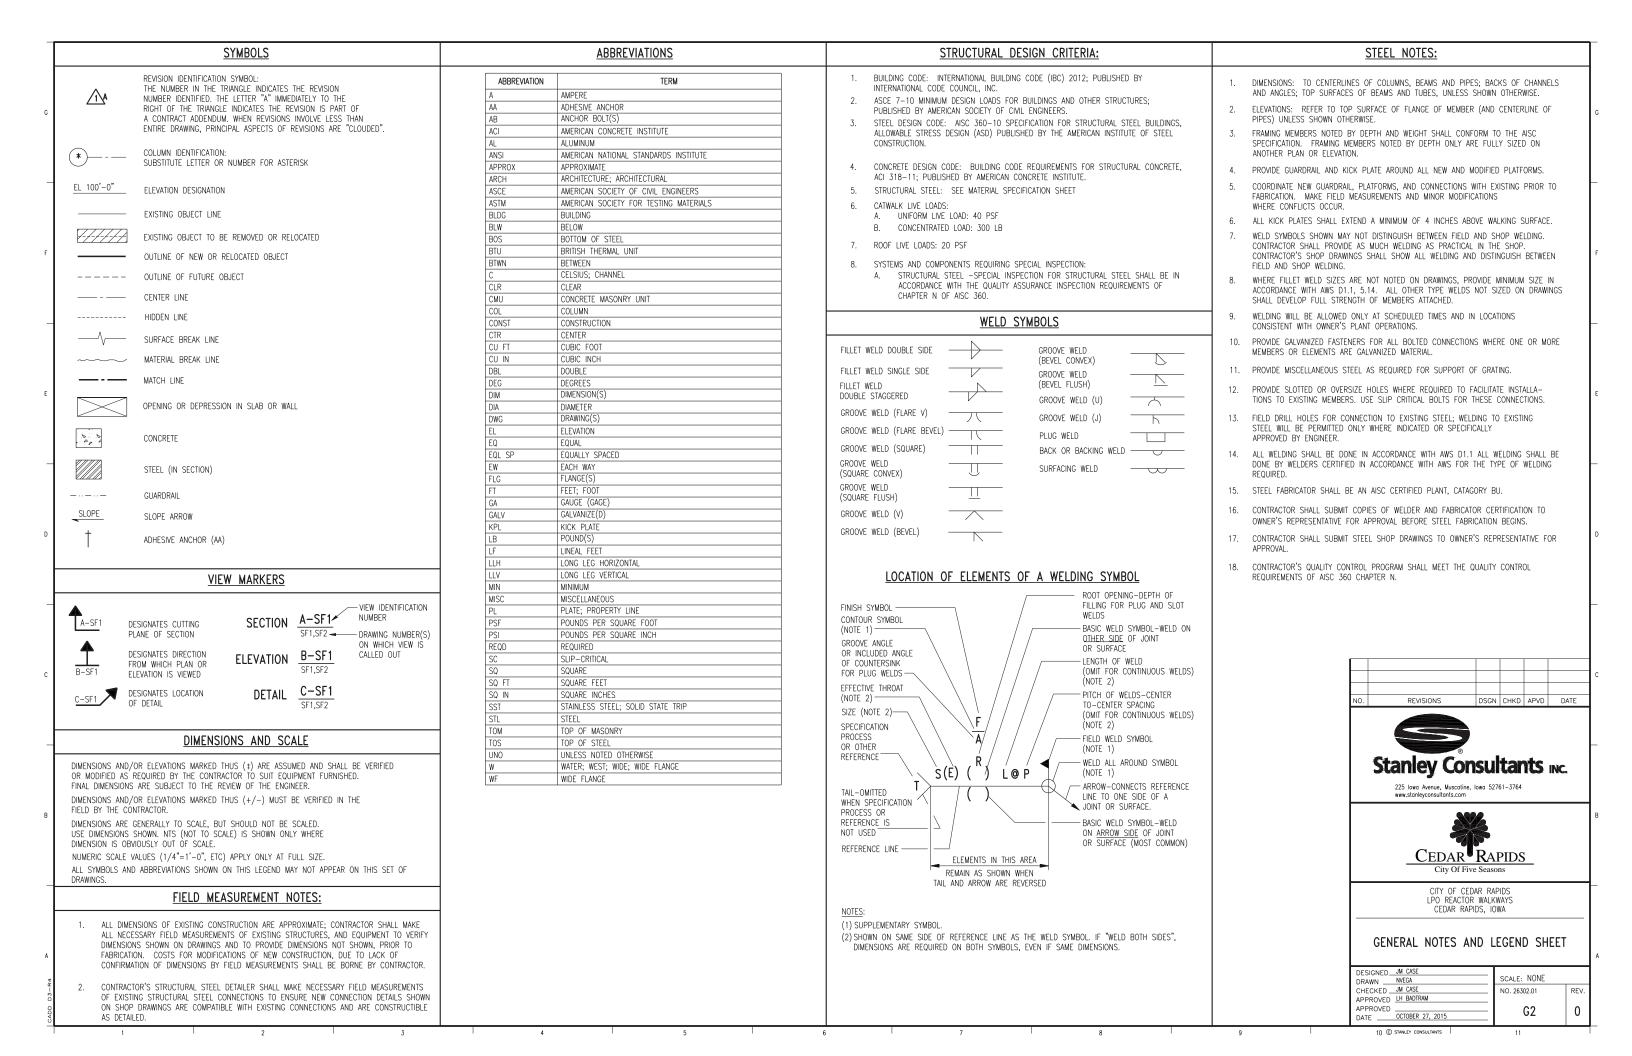



### **MATERIAL SPECIFICATIONS:** STRUCTURAL STEEL A. MATERIAL: ASTM A36. B. HOT DIP GALVANIZED AFTER FABRICATION ASTM A123. AFTER ERECTION, REPAIR HOT-DIP GALVANIZED COATINGS IN ACCORDANCE WITH ASTM A780. THIS INCLUDES SURFACES WHERE SHOP-APPLIED GALVANIZED COATINGS HAVE BEEN DAMAGED, REMOVED, OR OMITTED. 2. ADHESIVE ANCHORS A. THREADED RODS ANCHORED IN CONCRETE WITH 2-COMPONENT BLEND OF RESIN AND HARDENER. FILLER MATERIAL MAY BE MIXED WITH RESIN AND HARDENER IN ACCORDANCE WITH MANUFACTURER'S DIRECTIONS. B. ANCHOR ROD SYSTEM SHALL HAVE ICC APPROVAL FOR USE IN CRACKED CONCRETE AND FOR SEISMIC CONDITIONS AND SHALL HAVE PASSED MANDATORY CREEP TESTS REQUIREMENTS OF AC C. THREADED ROD TYPE: ALL-THREADED. STANDARD: ASTM A36/A36M, GALVANIZED. USE UNLESS INDICATED OTHERWISE ON DRAWINGS. HIGH-STRENGTH: ASTM A193/A193M, GRADE B7, GALVANIZED. 4. STAINLESS STEEL: ASTM F593 (AISI 304). D. MANUFACTURER: "HIT-HY 200 SAFE SET SYSTEM" BY HILTI, OR EQUAL. INSTALL IN STRICT ACCORDANCE WITH MANUFACTURER'S WRITTEN INSTRUCTIONS. F. PERFORM WORK USING MANUFACTURER'S STANDARD EQUIPMENT INCLUDING ADHESIVE CARTRIDGES, DISPENSING GUNS, MIXER TUBES AND EXTENSIONS, BRUSH, AND AIR NOZZLE FOR COMPRESSED AIR CLEANING OF HOLES. CONTRACTOR SHALL POSSESS EQUIPMENT AT SITE PRIOR TO START OF INSTALLATION AND WORKERS SHALL DEMONSTRATE KNOWLEDGE OF PROCEDURE FOR INSTALLING ANCHORS PRIOR TO INSTALLATION. G. USE HAMMER DRILL EXCEPT WHERE HOLES ARE WITHIN 6" (150 MM) OF EDGE OF CONCRETE H. INSPECT EXISTING CONCRETE AT ANCHOR LOCATIONS FOR SOUNDNESS. REPORT TO OWNER'S REPRESENTATIVE CRACKED, DETERIORATED OR WEAK CONCRETE DETECTED FROM DRILLING OPERATION OR FROM INSPECTION. 3. STEEL HANDRAILS AND GUARDRAILS A. MATERIAL: ASTM A53/A53M, GRADE B OR ASTM A501. B. USE STEEL PIPE FOR RAILS AND UPRIGHTS. CONNECTIONS: WELD AND GRIND SMOOTH. D. CONFORM TO DETAILS SHOWN ON DRAWINGS. 4. GRIP STRUT WALKWAY GRATING A. PROVIDE FABRICATED WALKWAY SECTIONS WITH INTEGRAL KICK PLATES AND SERRATED WALKING B. MATERIAL: GALVANIZED STEEL C. USE SERRATED GRIP STRUT GRATING D. THICKNESS: 12-GAGE (2.7 MM) MINIMUM. E. PROVIDE MANUFACTURER'S RECOMMENDED FASTENERS FOR EACH SECTION OF WALKWAY SUPPORTED ON STRUCTURAL MEMBERS. PROVIDE MANUFACTURER'S SPLICE PLATES AND OTHER REQUIRED ACCESSORIES. G. PROVIDE EDGE BINDING AT EXPOSED EDGES AND AS REQUIRED TO STIFFEN IRREGULAR H. SECURELY FASTEN EACH SECTION OF WALKWAY TO STRUCTURAL STEEL. I. MANUFACTURER: McNICHOLS HEAVY DUTY GRIP STRUT WALKWAY OR EQUAL. 5. EXPANDED METAL GRATING A. MATERIAL: CARBON STEEL SURFACE: STANDARD, SLIP RESISTANT. STYLE: GALVANIZED. MANUFACTURER: McNICHOLS EXPANDED METAL GRATING OR EQUAL. CLEAR SPAN: 5'-0" MIN. SECURELY FASTEN EACH SECTION OF METAL GRATING TO STRUCTURAL STEEL IN ACCORDANCE WITH MANUFACTURER'S RECOMMENDATIONS. 6. HIGH STRENGTH BOLT ASSEMBLIES A. BOLTS: ASTM A325, HEAVY HEX B. NUTS: ASTM A563, HEAVY HEX REVISIONS DSGN CHKD APVD DATE C. WASHERS: ASTM FY36 D. HOT DIP GALVANIZED, ASTM A153 AND A143 Stanley Consultants INC. 225 Iowa Avenue, Muscatine, Iowa 52761-3764 CEDAR RAPIDS CITY OF CEDAR RAPIDS LPO REACTOR WALKWAYS CEDAR RAPIDS, IOWA MATERIAL SPECIFICATIONS DESIGNED JM CASE SCALE: NONE DRAWN NVEGA CHECKED JM CASE NO. 26302.01


DATE OCTOBER 27, 2015

APPROVED LH BADTRAM

G3

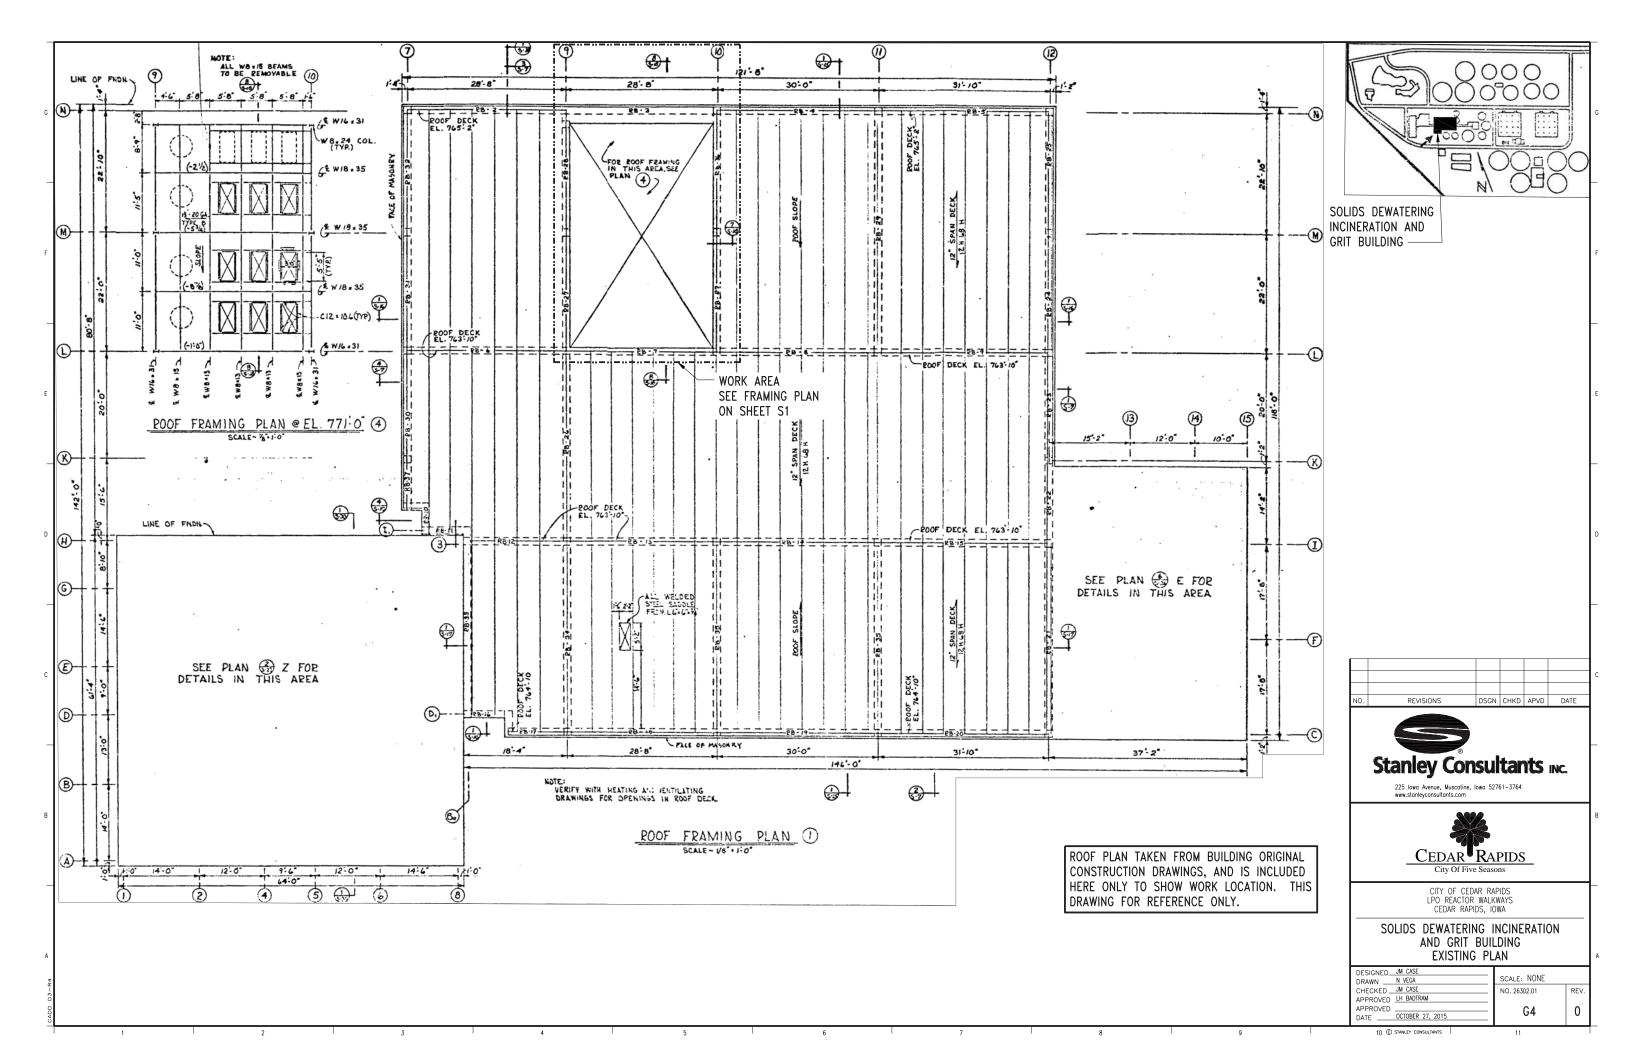

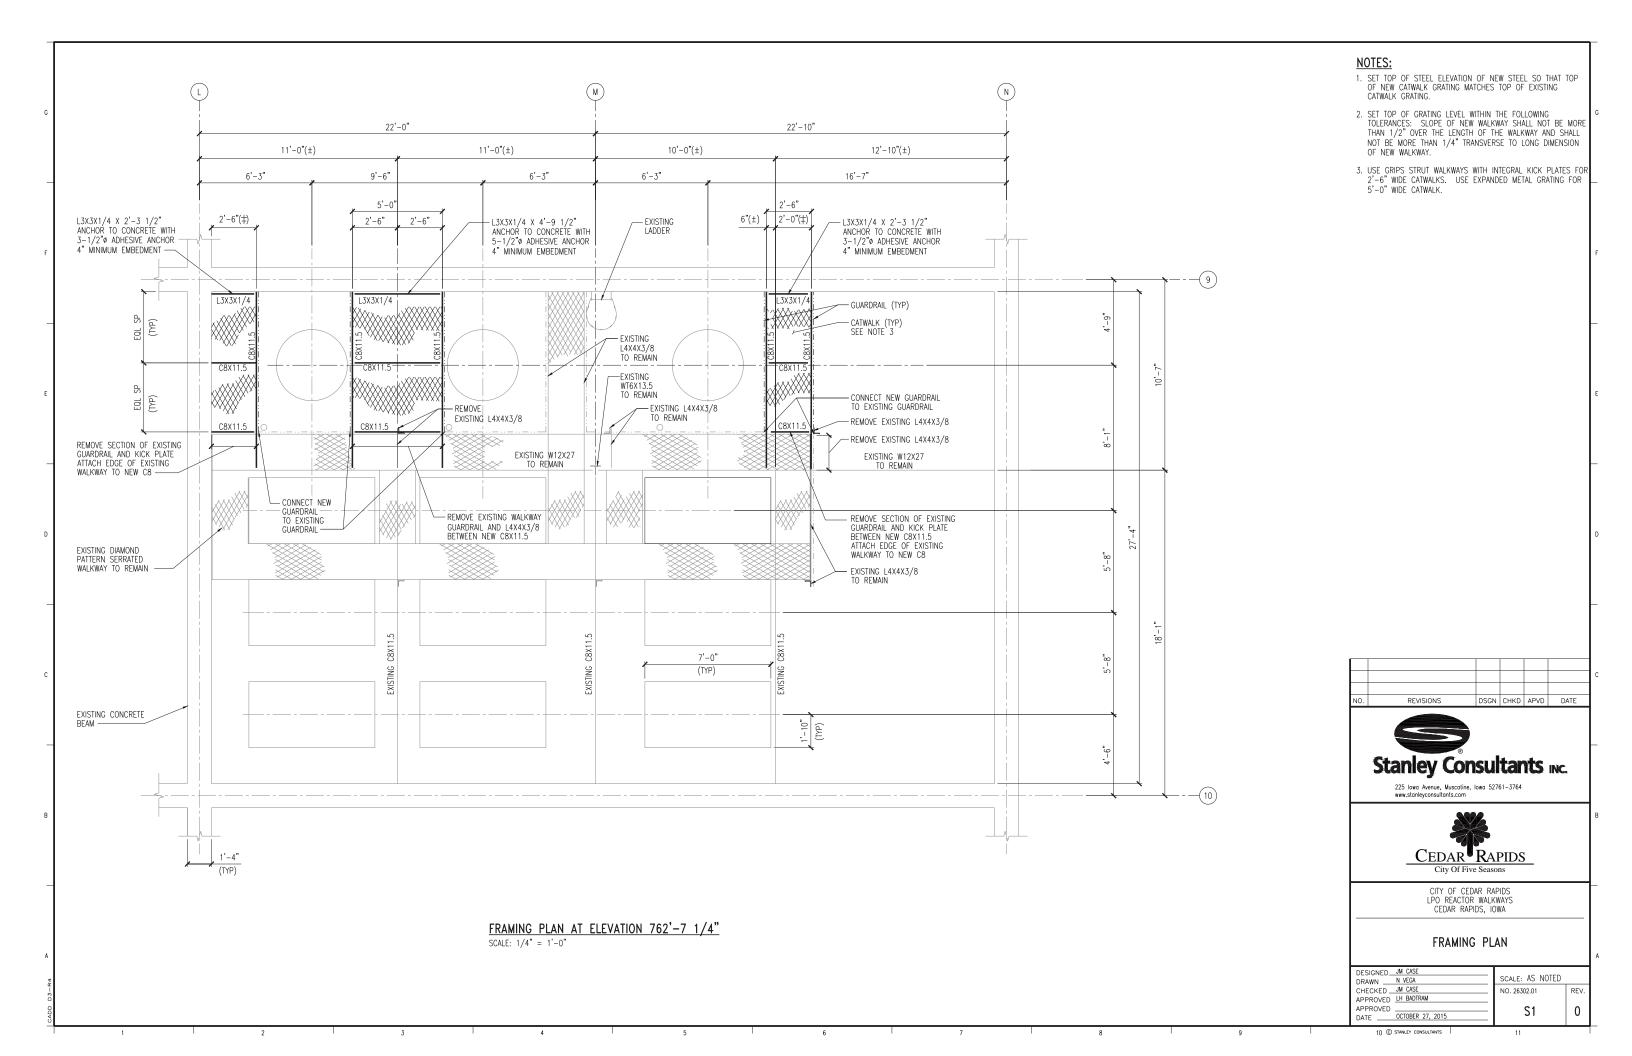


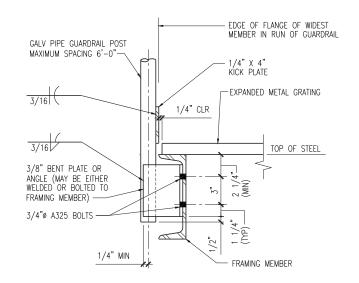


- NOTES:

  1. TOP GUARDRAIL 2'-6" ABOVE WALKWAY SURFACE. MIDDLE GUARDRAIL HEIGHT TO MATCH EXISTING.
- 2. GUARDRAILS AND POSTS SHALL BE 1 1/2" DIAMETER STANDARD WEIGHT STEEL PIPE ASTM A53. GRADE B OR ASTM A501.
- 3. OMIT KICK PLATE WHERE KICK PLATE IS

#### TYPICAL GUARDRAIL AND KICK PLATE DETAIL SCALE: NONE

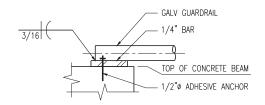

ALTERNATE MIDDLE GUARDRAIL ATTACHMENT TO CONCRETE DETAIL SCALE: NONE

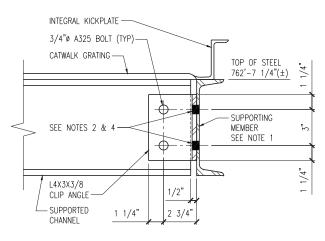


#### NOTES:

- 1. CONNECTION TYPICAL FOR CHANNEL TO CHANNEL, CHANNEL TO EXISTING W12X27 AND CHANNEL TO EXISTING CONCRETE BEAM CONNECTIONS. CHANNEL TO CHANNEL CONNECTION
- 2. FOR CONNECTION OF CHANNEL TO EXISTING W12X27 AND CONNECTION OF CHANNELS, CLIP ANGLE MAY BE BOLTED OR WELDED TO W12X27 OR SUPPORTING CHANNEL AT CONTRACTOR'S OPTION. FOR BOLTED CONNECTIONS USE 3/4" DIAMETER A325 BOLTS FOR EACH MEMBER AS SHOWN.
- 3. COPE TOP OF C8 AS NEEDED WHEN FRAMING INTO EXISTING W12X27 TO MAINTAIN SAME TOP OF GRATING ELEVATION WITH EXISTING CONSTRUCTION.
- 4. FOR CONNECTION OF CHANNEL TO EXISTING CONCRETE BEAM USE TWO 1/2" STEEL THREADED ROD ADHESIVE ANCHORS WITH 4" MINIMUM EMBEDMENT. SEE MATERIAL NOTES FOR ADHESIVE ANCHOR REQUIREMENTS.


#### TYPICAL BEAM CONNECTION DETAIL

SCALE: 3"=1'-0"

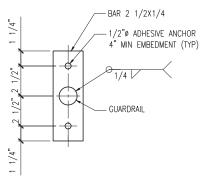

#### GUARDRAIL ATTACHMENT TO CONCRETE DETAIL

SCALE: 3"=1'-0"

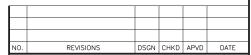



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#### TYPICAL DETAILS

ı	DESIGNED_ DRAWN	JM CASE NVEGA	SCALE: AS NOTED
ı	CHECKED _ APPROVED	JM CASE LH BADTRAM	NO. 26302.01
ı	APPROVED DATE	OCTOBER 27, 2015	S2

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